

MIAMI-DADE COUNTY, FLORIDA METRO-DADE FLAGLER BUILDING 140 WEST FLAGLER STREET, SUITE 1603 MIAMI, FLORIDA 33130-1563 (305) 375-2902 FAX (305) 372-6339

# NOTICE OF ACCEPTANCE (NOA)

www.miamidade.gov/buildingcode

Kawneer Company Inc. 555 Guthridge Court Norcross, GA 30092

Scope:

This NOA is being issued under the applicable rules and regulations governing the use of construction materials. The documentation submitted has been reviewed by Miami-Dade County Product Control Division and accepted by the Board of Rules and Appeals (BORA) to be used in Miami Dade County and other areas where allowed by the Authority Having Jurisdiction (AHJ).

This NOA shall not be valid after the expiration date stated below. The Miami-Dade County Product Control Division (In Miami Dade County) and/or the AHJ (in areas other than Miami Dade County) reserve the right to have this product or material tested for quality assurance purposes. If this product or material fails to perform in the accepted manner, the manufacturer will incur the expense of such testing and the AHJ may immediately revoke, modify, or suspend the use of such product or material within their jurisdiction. BORA reserves the right to revoke this acceptance, if it is determined by Miami-Dade County Product Control Division that this product or material fails to meet the requirements of the applicable building code. This product is approved as described herein, and has been designed to comply with the Florida Building Code, including the High Velocity Hurricane Zone.

DESCRIPTION: Series "350 IR" Aluminum Outswing Storefront Door 6'0" x 9'0"- L.M.I.

**APPROVAL DOCUMENT:** Drawing No. **1569**, titled "350 IR 9" Outswing Aluminum Storefront Doors – LMI", sheets 1 through 7 of 7, prepared by W.W. Schaefer Engineering & Consulting, P.A., dated 04/02/08, signed and sealed by Warren W. Schaefer, P. E., bearing the Miami-Dade County Product Control Approval stamp with the Notice of Acceptance number and Approval date by the Miami-Dade County Product Control Division.

# MISSILE IMPACT RATING: Large and Small Missile Impact Resistant

**LABELING:** Each unit shall bear a permanent label with the manufacturer's name or logo, city, state and following statement: "Miami-Dade County Product Control Approved", unless otherwise noted herein.

**RENEWAL** of this NOA shall be considered after a renewal application has been filed and there has been no change in the applicable building code negatively affecting the performance of this product.

**TERMINATION** of this NOA will occur after the expiration date or if there has been a revision or change in the materials, use, and/or manufacture of the product or process. Misuse of this NOA as an endorsement of any product, for sales, advertising or any other purposes shall automatically terminate this NOA. Failure to comply with any section of this NOA shall be cause for termination and removal of NOA.

**ADVERTISEMENT:** The NOA number preceded by the words Miami-Dade County, Florida, and followed by the expiration date may be displayed in advertising literature. If any portion of the NOA is displayed, then it shall be done in its entirety.

**INSPECTION:** A copy of this entire NOA shall be provided to the user by the manufacturer or its distributors and shall be available for inspection at the job site at the request of the Building Official. This NOA consists of this page 1 and evidence pages E-1 and E-2, as well as approval document mentioned above.

The submitted documentation was reviewed by Fitz A. Harris, P. E.

Dits A Harris

NOA No. 08-0219.07 Expiration Date: April 22, 2014

Approval Date: April 22, 2009

MIAMI-DADE COUNTY
APPROVED

Page 1

#### Kawneer Company Inc.

### NOTICE OF ACCEPTANCE: EVIDENCE SUBMITTED

#### A. DRAWINGS

- 1. Manufacturer's die drawings and sections.
- 2. Drawing No 1569, titled "350 IR 9" Outswing Aluminum Storefront Doors LMI", sheets 1 through 7 of 7, prepared by W.W. Schaefer Engineering & Consulting, P.A., dated 04/02/08, signed and sealed by Warren W. Schaefer, P.E.

#### B. TESTS

- 1. Test reports on: 1) Air Infiltration Test, per FBC, TAS 202-94
  - 2) Water Infiltration resistant Test (Not Performed)
  - 3) Uniform Static Air Pressure Test, Loading per FBC TAS 202-94
  - 4) Large Missile Impact Test per FBC, TAS 201-94
  - 5) Cyclic Wind Pressure Loading per FBC, TAS 203-94
  - 6) Forced Entry Test, Per FBC 2411 3.2.1 and TAS 202-94

along with marked-up drawings and installation diagrams of aluminum outswing storefront doors, prepared by Hurricane Test Laboratory, Inc., Test Reports No. HTL-0049-0611-04 dated 06-07-04, HTL-0049-1106-04 dated 11/03/04 and G049-1005-06 dated 10/03/06, all signed and sealed by Vinu J. Abraham, P. E.

#### C. CALCULATIONS

1. Anchor verification, comparative and structural analysis, prepared by W. W. Schaefer Engineering & Consulting, P.A., dated 02/14/08, signed and sealed by Warren W. Schaefer, P. E.

Complies with ASTM E1300 - 02

#### D. QUALITY ASSURANCE

1. Miami Dade Building Code Compliance Office (BCCO).

#### E. MATERIAL CERTIFICATIONS

1. Notice of Acceptance No. **06-0216.06** issued to Solutia Inc. for their "Saflex IIIG Clear or colored interlayer" dated May 04, 2006, expiring on May 21, 2011.

#### F. STATEMENTS

- 1. Statement letter of conformance and no financial interest, dated January 21, 2008, signed and sealed by Warren W. Schaefer, P. E.
- 2. Laboratory compliance letter (HTL-04047), issued by Hurricane Test Laboratory, Inc., dated February 24, 2005, signed and sealed by Vinu J. Abraham, P. E.

Fitz A. Harris, P.E.

Product Control Examiner NOA No. 08-0219.07

Expiration Date: April 22, 2014 Approval Date: April 22, 2009

## Kawneer Company Inc.

# NOTICE OF ACCEPTANCE: EVIDENCE SUBMITTED

- F. STATEMENTS (CONTINUED)
  - 3. Laboratory addendum letter for Test Report No.'s HTL-0049-0611-04 and HTL-0049-1106-04, issued by Hurricane Test Laboratory, Inc., dated February 10, 2009, signed and sealed by Vinu J. Abraham, P. E.
- G. OTHERS
  - 1. None

Fitz A. Harris, P.E.

Product Control Examiner

NOA No. 08-0219.07

Expiration Date: April 22, 2014 Approval Date: April 22, 2009

#### **GENERAL NOTES:**

1. THESE DOOR SYSTEMS HAVE BEEN TESTED, ANALYZED & APPROVED FOR DESIGN PRESSURES NOT TO EXCEED THOSE SHOWN IN THE "ALLOWABLE DESIGN PRESSURE TABLE(S).
2. OPENINGS, BUCKING & BUCKING FASTENERS MUST BE PROPERLY DESIGNED & INSTALLED TO TRANSFER WIND LOADS TO THE STRUCTURE.

3. ALL HARDWARE & FASTENERS SHALL BE IN ACCORDANCE WITH THESE DRAWINGS & SHALL NOT VARY UNLESS SPECIFICALLY MENTIONED ON THE DRAWINGS. SPECIFIED ANCHOR EMBED TO BASE MATERIAL SHALL BE BEYOND WALL FINISH OR STUCCO.

**4.** THE DETAILS & SPECIFICATIONS SHOWN HEREIN REPRESENT THE PRODUCTS TESTED & PROPOSED FOR AIR, IMPACT, CYCLIC & UNIFORM STATIC AIR PRESSURE TESTING IN CONFORMANCE WITH THE FLORIDA BUILDING CODE PROTOCALS TAS-201, 202 & 203 FOR LARGE MISSILE IMPACT DOORS.

5. THESE DOOR SYSTEMS HAVE BEEN DESIGNED IN ACCORDANCE WITH AND MEET THE REQUIREMENTS OF THE FLORIDA BUILDING CODE (FBC) INCLUDING HIGH VELOCITY HURRICANE ZONES (HVHZ).

6. IMPACT SHUTTERS ARE NOT REQUIRED WITH THESE DOORS.

7. ALL ANCHORS SECURING DOOR FRAME TO PRESSURE TREATED BUCKS OR WOOD FRAMING SHALL BE CAPABLE OF RESISTING CORROSION CAUSED BY THE PRESSURE TREATING CHEMICALS IN THE WOOD.

8. DETERMINE THE POSITIVE & NEGATIVE DESIGN LOADS TO USE WHEN REFERENCING THESE DOCUMENTS IN ACCORDANCE WITH THE GOVERNING CODE AND GOVERNING WIND VELOCITY. FOR WIND LOAD CALCULATIONS IN ACCORDANCE WITH THE FLORIDA BUILDING CODE, A DIRECTIONALITY FACTOR OF Kd = 0.85 MAY BE APPLIED WHEN USED IN CONJUNCTION WITH LOAD COMBINATIONS SPECIFIED IN SECTION 2.0 OF THE ASCE 7 STANDARD.

9. NO INCREASE IN ALLOWABLE STRESS HAS BEEN USED IN THE CERTIFICATION OF THIS PRODUCT. WIND LOAD DURATION FACTOR Cd=1.6 was used for wood screw analysis only.


10. MATERIALS, INCLUDING BUT NOT LIMITED TO STEEL SCREWS, THAT COME INTO CONTACT WITH OTHER DISSIMILAR MATERIALS SHALL MEET THE REQUIREMENTS OF FLORIDA BUILDING CODE CHAPTER 20.

# CORNER & FRAME END CONSTRUCTION FOR SHEET 1 ELEVATIONS:

FRAME HEAD CORNER: HEAD IS SQUARE CUT, BUTTED TO SIDE, FASTENED WITH THREE (3) NO. 12 X 1" S.S. PHTFS FASTENERS THROUGH THE SIDE MEMBER INTO THE HEAD MEMBER SCREW SPLINES & SEALED WITH SILICONE.

FRAME SILL CORNER: SILL IS SQUARE CUT, BUTTED TO SIDE, SECURED TO THE SIDE MEMBER USING A PIVOT ASSEMBLY OR STEEL CLIP, FASTENED WITH THREE (3) NO. 12-24 X 3/8" FHMS AT THE FRAME & TWO (2) NO. 12-24 X 3/8" FHMS AT THE SILL, & SEALED WITH SILICONE.

DOOR PANEL CORNERS: VERTICAL STILES RUN THROUGH AND ARE SECURED TO THE RAILS AT THE TOP & BOTTOM WITH 1/4" THICK EXTRUDED CHANNELS. EACH CHANNEL IS FASTENED TO THE STILE & RAIL WITH 1/4-20 X 3/4" PHMS & 3/16" THICK STEEL NUT PLATES. THE INTERSECTION OF EACH CORNER JOINT WAS WELDED WITH A 1/2" DIA. PLUG WELD AND A 1 1/8" LONG FILLET WELD AT BOTH WEBS OF THE RAIL.

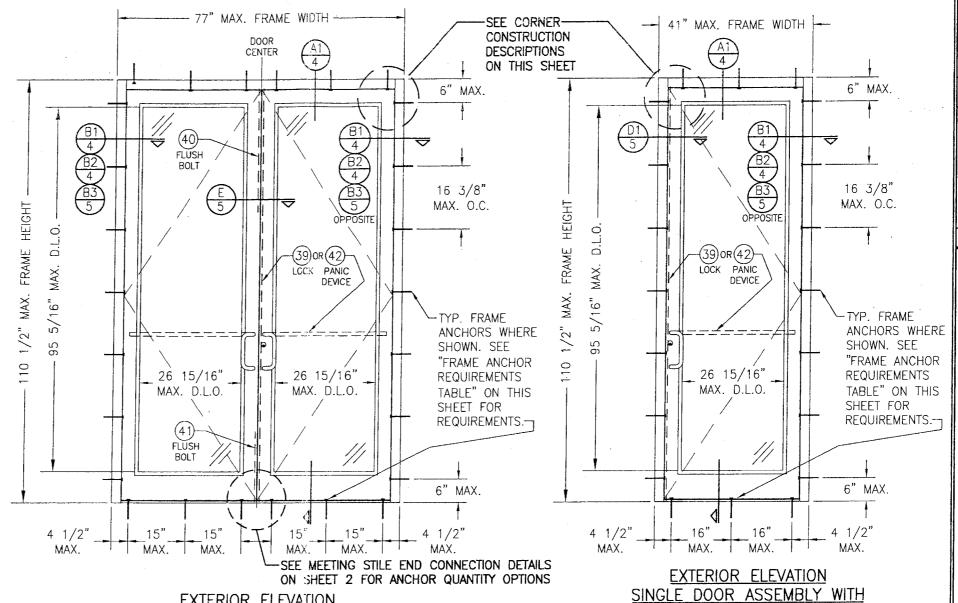

EXTERIOR ELEVATION

DOUBLE DOOR ASSEMBLY WITH STORE FRONT FRAMING

SCALE: 1/2"=1'-0"

# SCALE: 1/2"=1'-0"

ļ	FRAME ANCHOR REQUIREMENTS TABLE					
	FRAME SHEAR SCREWS					
ANCHOR TYPE	OPENING TYPE (SUBSTRATE)	FRAME/CLIP/NAIL FIN TO OPENING FASTENER TYPE	MINIMUM EMBED	MINIMUM EDGE DIST		
А	MIN. 2X4 WOOD FRAME OR BUCK (MIN. GR. 3 & G=0.55)	NO. 12 SMS OR WOOD SCREW	1 1/4"	3/4"		
В	MIN. 16 GA. 50 KSI METAL STUD	(2) NO. 12 GR. 5 SELF TAP/DRILLING SCREW	FULL	1/2"		
C MIN. 0.22" THICK A36 STEEL	(2) 1/4-14 SELF DRILL/TAPPING SCREW	FULL	1/2"			
D	MIN. 0.1" THK 6063-T6 ALUM. /CURTAIN WALL	(2) 1/4-14 SELF DRILL/TAPPING SCREW	FULL	1/2"		
E	(3)C-90 CMU/3000 PSI CONCRETE	(1) 1/4" CONCRETE SCREW	1 1/4"	2"		

FRAME ANCHOR REQUIREMENTS TARLE

- (1) CONCRETE SCREWS SHALL BE ELCO OR ITW RAMSET/RED HEAD TAPCONS, HILTI KWIK-CON II OR POWERS RAWL TAPPER (HARDENED STEEL OR S.S.).
- (2) SELF DRILLING & SELF TAPPING SCREWS SHALL BE MIN. GRADE 5 CORRISION RESISTANT STEEL
- (3) C-90 CMU IS ONLY APPLICABLE AT SIDES OF DOOR OPENING (NOT APPLICABLE TO HEAD & SILL)

ALLOWABLE DESIGN PRESSURE +/-65 PSF

(\*) THESE DOORS ARE NOT APPROVED FOR USE WHERE WATER INFILTRATION RESISTANCE IS REQUIRED BY THE DOOR. UNLESS UNITS ARE INSTALLED IN NON—HABITABLE AREAS WHERE THE UNIT & THE AREA ARE DESIGNED TO ACCEPT WATER INFILTRATION, UNITS SHALL BE INSTALLED ONLY AT LOCATIONS PROTECTED BY A CANOPY OR OVERHANG SUCH THAT THE ANGLE BETWEEN THE EDGE OF THE CANOPY OR OVERHANG TO SILL IS LESS THAN 45 DEGREES.

Approved as constraint with the Merica Building Crain Grant Grant

STORE FRONT FRAMING

CERTIFICATION
DRAW
ON SUMMER OF THE CON
ON SCHAEFER W. SCHAEFER P.E. NO. 44135 P.E.

SCHAEFER ENGINEERING CONSULTING, P.A.

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CHECKED BY: W.W.S.

04/02/08

KAWNEER COMPANY, INC. 555 GUTHRIDGE COURT NORCROSS, GA 30092 770-449-5555

DOORS

STOREFRONT

ALUMINUM


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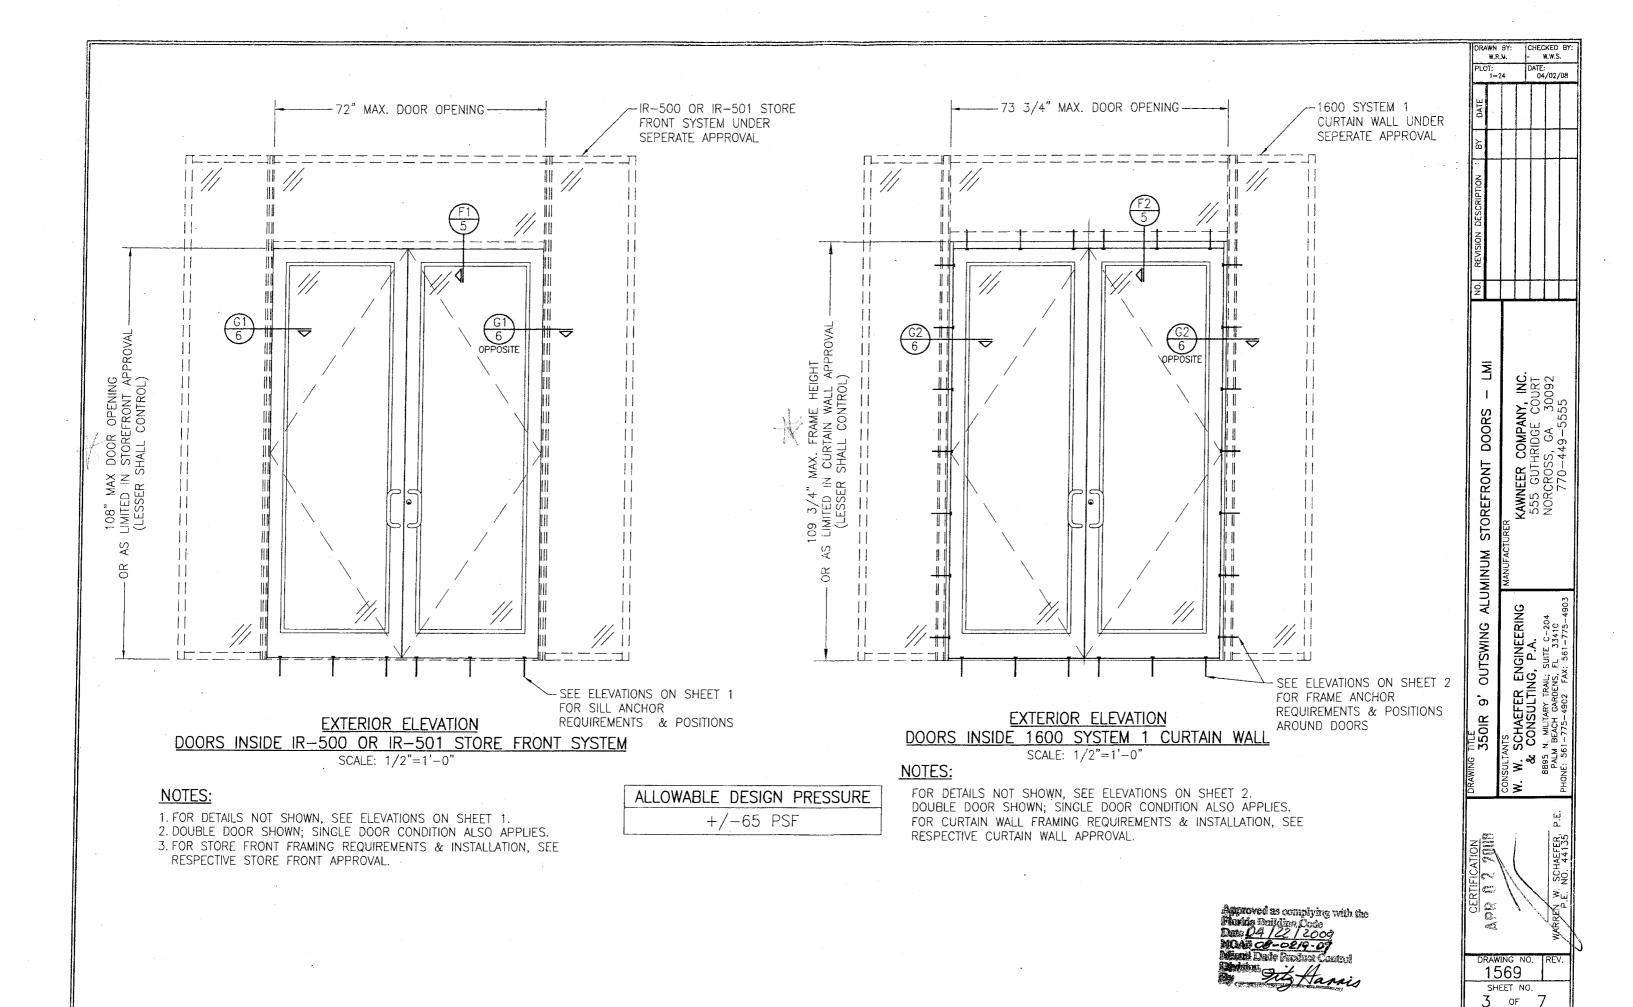
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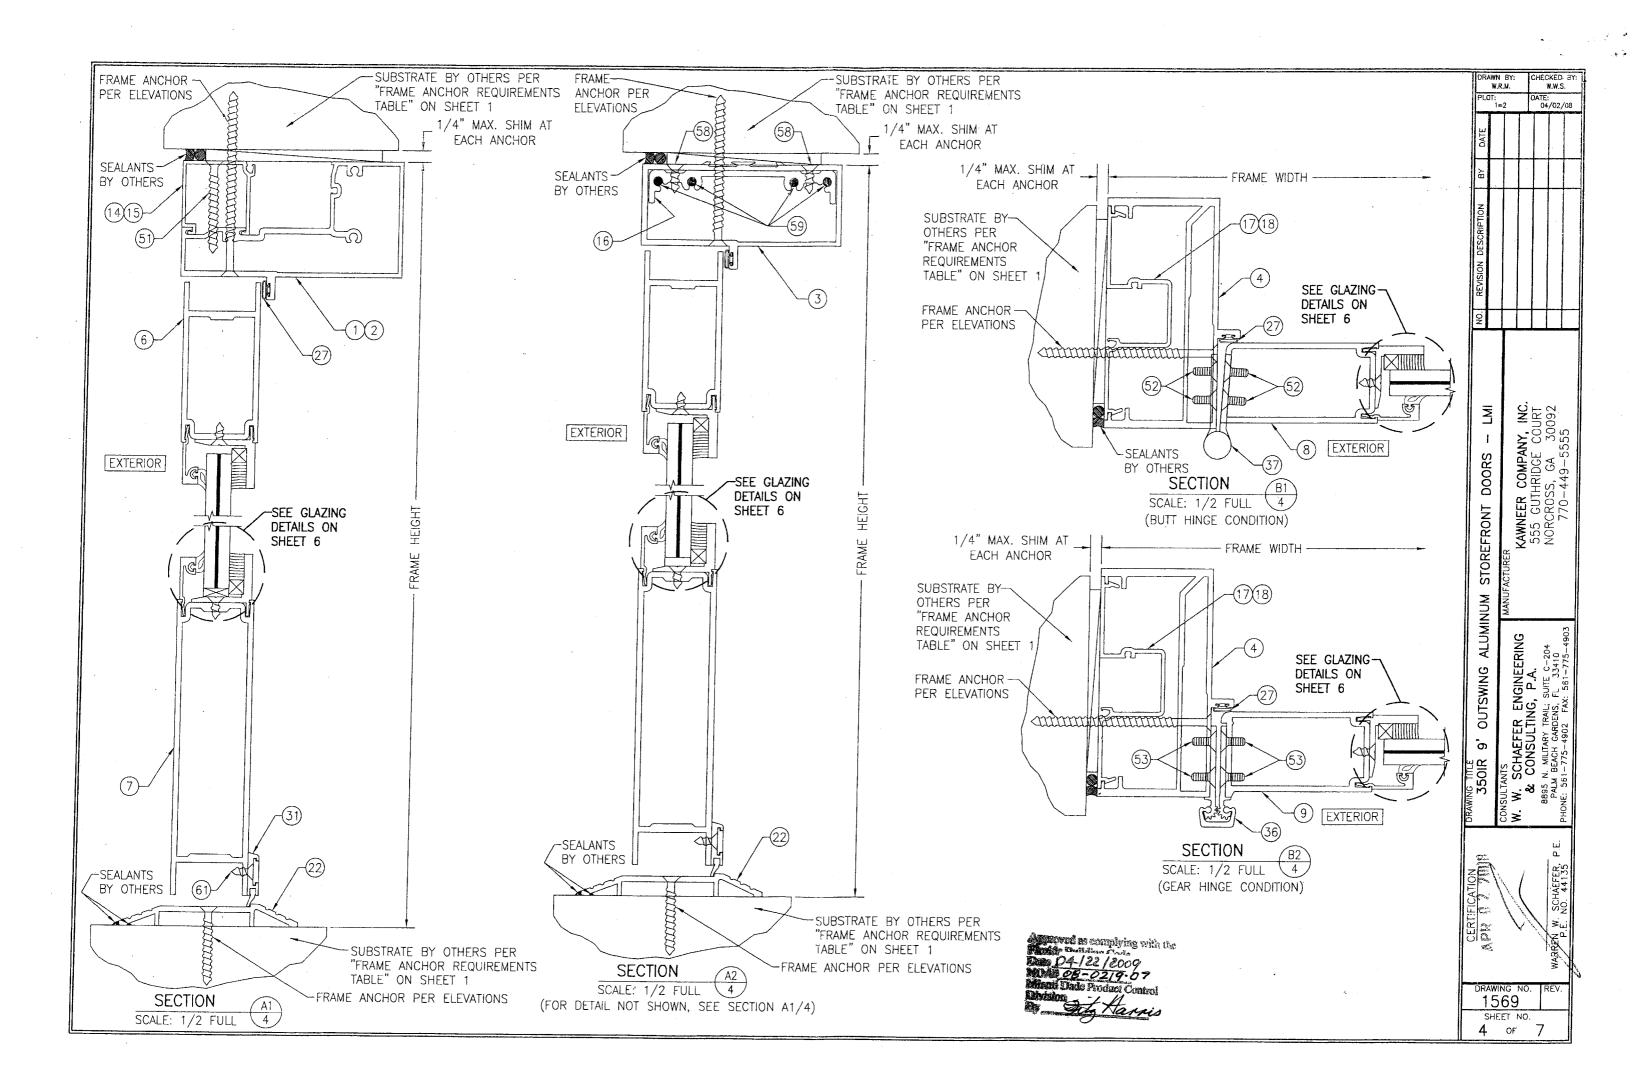
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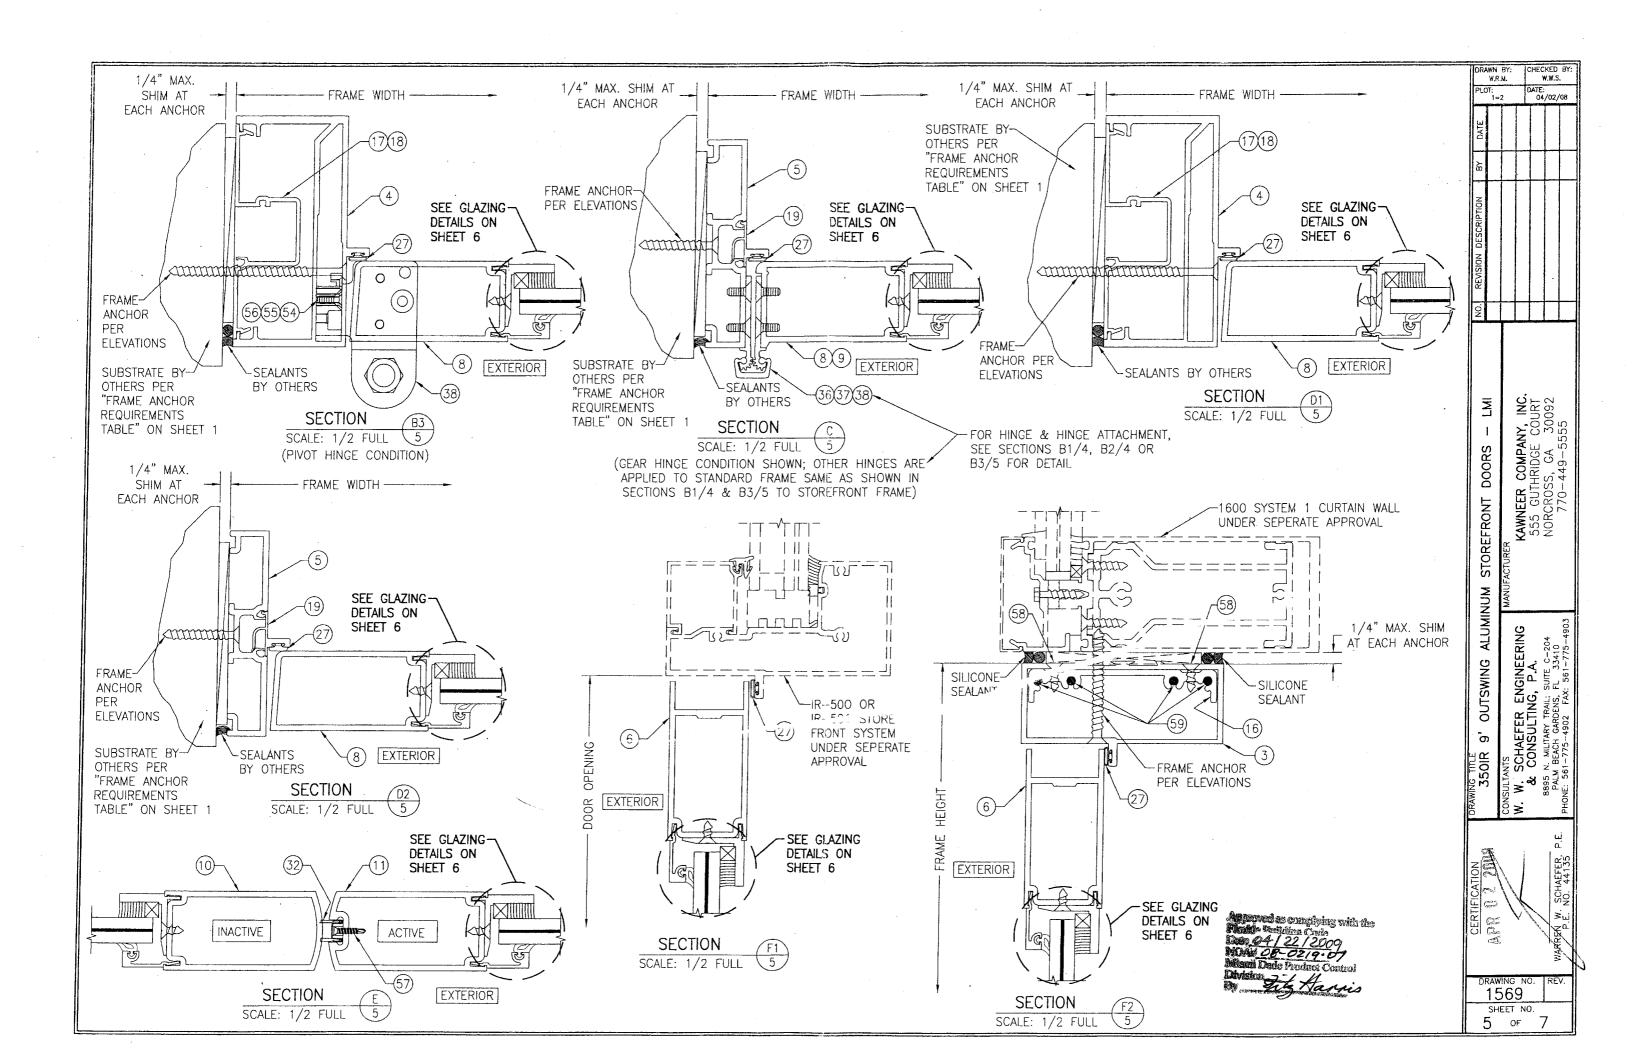
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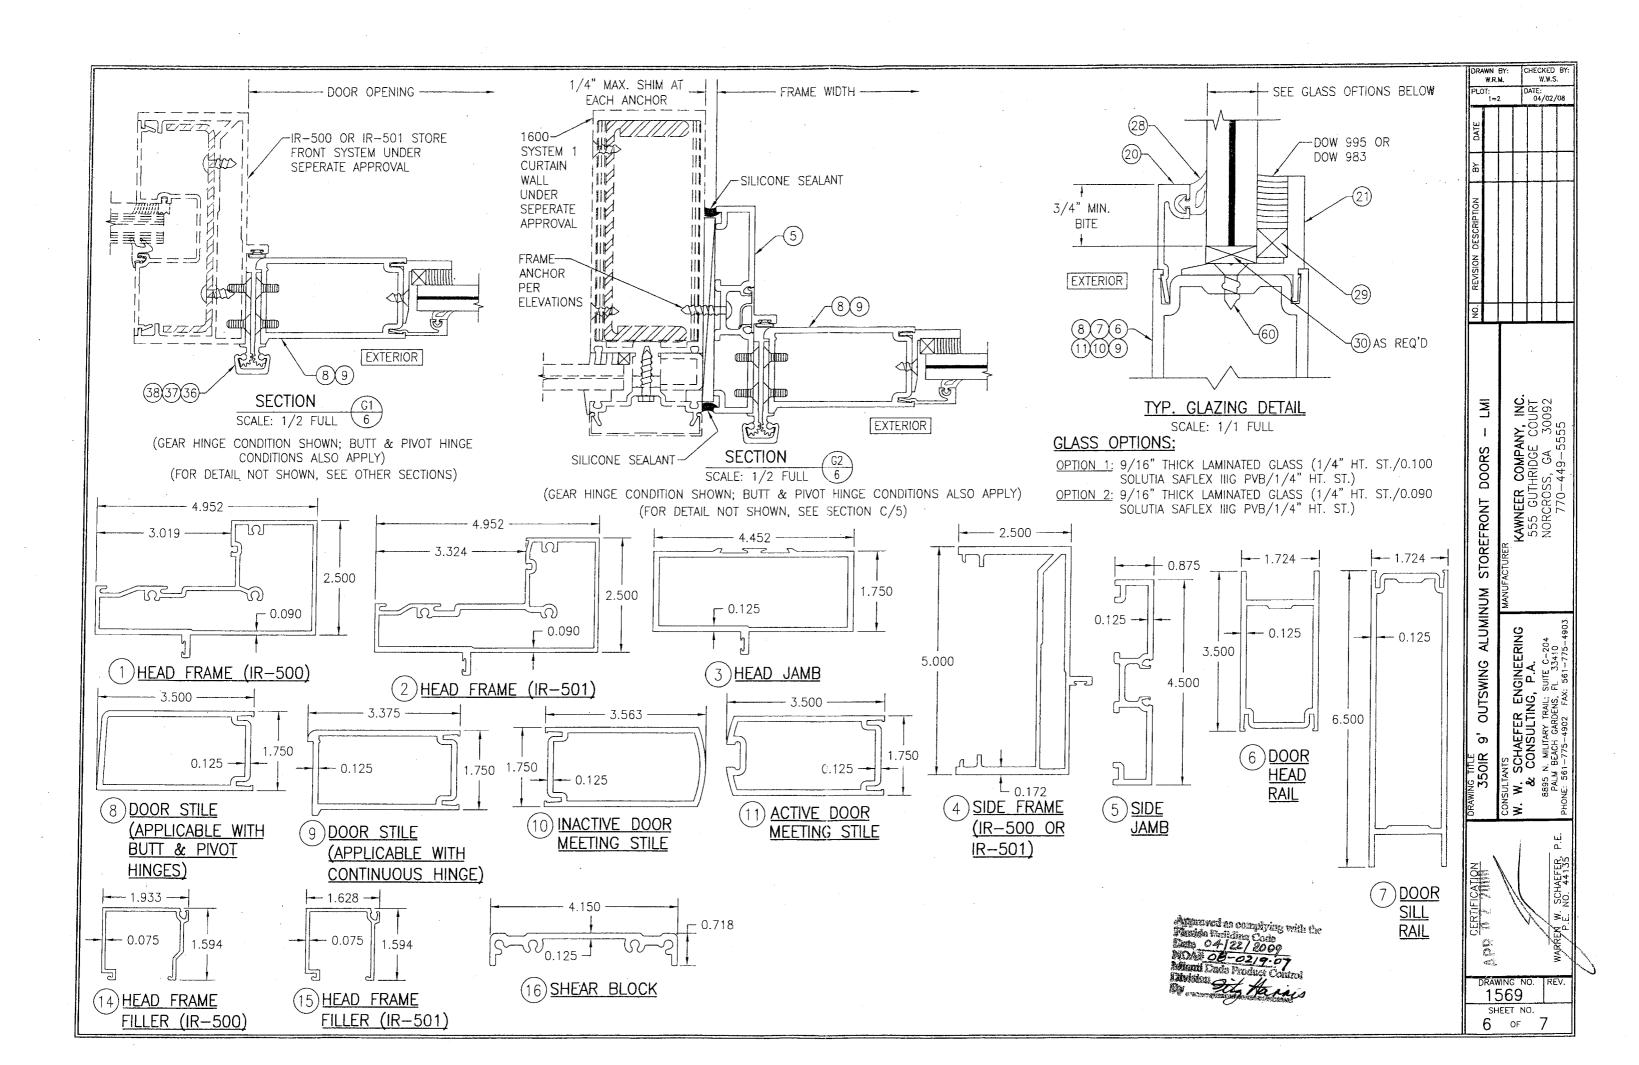
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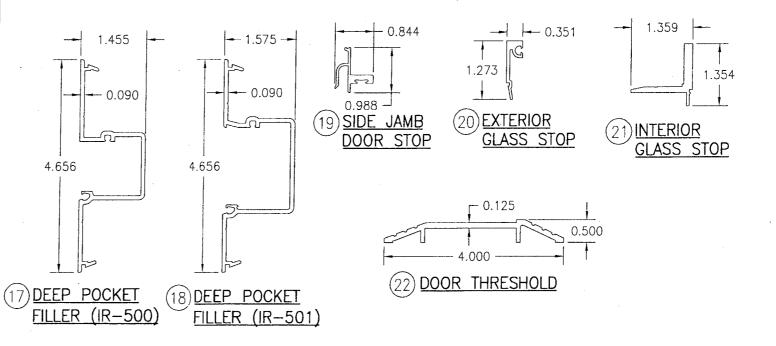







ITEM	# PART #	ITEM DESCRIPTION	MANUFACTURER/NOTES
		PARTS	
11	575-022	HEAD FRAME (IR-500)	6063-T6 ALUMINUM
2	575-122	HEAD FRAME (IR-501)	6063-T6 ALUMINUM
3	450-502	HEAD JAMB	6063-T6 ALUMINUM
4	575-051	SIDE FRAME (IR 500-OR IR-501)	6063-T6 ALUMINUM
5	163-036	SIDE FRAME (1600 DR JB ADAPTOR)	6063-T6 ALUMINUM
6		DOOR; TOP RAIL	6063-T6 ALUMINUM
7		DOOR; BOTTOM RAIL	6063-T6 ALUMINUM
8		DOOR STILE (APPLICABLE WITH BUTT	
		& PIVOT HINGES)	
9	200-012	DOOR STILE (APPLICABLE WITH	6063-T6 ALUMINUM
	200 012	CONTINUOUS HINGES)	To Alemintoni
10	200-007	INACTIVE DOOR MEETING STILE	6063-T6 ALUMINUM
11		ACTIVE DOOR MEETING STILE	6063-T6 ALUMINUM
14	<del></del>	HEAD FRAME FILLER (IR-500)	6063—T6 ALUMINUM
15		HEAD FRAME FILLER (IR-501)	6063-T6 ALUMINUM
16		SHEAR BLOCK	6063-T6 ALUMINUM
17		DEEP POCKET FILLER (IR-500)	
18		DEEP POCKET FILLER (IR-500)	6063-T6 ALUMINUM
		SIDE JAMB DOOR STOP	6063-T6 ALUMINUM
19	<del></del>		6063-T6 ALUMINUM
20	<del> </del>	EXTERIOR GLASS STOP	6063-T6 ALUMINUM
21	<del>                                     </del>	INTERIOR GLASS STOP	6063-T6 ALUMINUM
22	[069-139]	DOOR THRESHOLD	6063-T6 ALUMINUM
0.7	1007 0701	SEALS AND SEALANTS	
	<del> </del>	DOOR BULB WEATHERING	ALCRYN
		FIXED DOOR GASKET	EPDM
29		GLAZING TAPE / SILICONE SPACER	SEMI-RIGID POLYURETHANE FOAM
~~~~		DOOR SETTING BLOCK	NEOPRENE
		DOOR BOTTOM RAIL WEATHER SWEEP	VARIED
32	200-497	ADJUSTABLE ASTRAGAL WEATHERING	VARIED
	·	HARDWARE	<u> </u>
		CONTINUOUS GEAR HINGE	BY HAGER/ROTON
		BUTT HINGE	BY HAGER (4 PER PANEL)
- t		TOP OFFSET PIVOT HINGE	BY KAWNEER
	050-331	NTERMEDIATE OFFSET PIVOT HINGE	(4 HINGES PER PANEL)
	050-326 F	RH BOTTOM OFFSET PIVOT HINGE	
		H BOTTOM OFFSET PIVOT HINGE	
39		OCK ASSEMBLY FOR ACTIVE DOOR	BY ADAMS-RITE
		BOLT GUIDE	
	50-078 T		
	50-100 E	DEADLOCK	
	37-368 E	BOTTOM BOLT	
	35-001 C	YLINDER	BY KAWNEER
	37-176 T	HUMBTURN	
	137-700 C	CO-9 PUSH / CP-II PUSH	
.		ACKAGE	
0		NACTIVE DOOR TOP FLUSH BOLT	BY ADAMS-RITE
		NACTIVE DOOR BOTTOM FLUSH BOLT	BY ADAMS-RITE

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	ITEM #	PART #	ITEM DESCRIPTION	MANUFACTURER/NOTES	
	HARDWARE CONTINUED				
	42	-	CONCEALED ROD EXIT/PANIC DEVICE	DOROMATIC 1490	
1	MISCELLANEOUS FASTENERS				
	51	T -	NO. 12 X 2" SCREW	3" FROM ENDS & MAX. 11" O.C.	
	52	_	NO. 12-24 X 9/16" S.S SCREW	8 PER HINGE	
	53	_	NO. 12-24 X 13/32" SCREW	2 9/16" FROM ENDS & MAX. 5 1/8" O.C. (52 MAX. PER HINGE)	
1	54		5/16"-18 X 5/8" SCREW	2 PER TOP PIVOT HINGE	
	55	_	NO. 12-24 X 9/16" S.S SCREW	2 PER INTERMEDIATE PIVOT HINGE	
	56	_	1/4-20 X 3/8" SCREW	3 PER BOTTOM PIVOT HINGE	
	57	_	NO 6 X 11/16" SCREW	10 PER LEAF	
	58	_	NO. 10 X 9/16" S.S SCREW	2 PER CLIP	
	59	_	NO. 10 X 1 19/32" S.S. SCREW	4 PER CLIP	
	60	-	NO. 10 X 1/2" S.S. SCREW	3" FROM ENDS & MAX. 7 1/2"	
				O.C. AT TOP & BOTTOM RAILS -	
				3" FROM ENDS & MAX. 11 1/8"	
				O.C. AT STILES	
	61	_	NO. 6 X 3/8" S.S. SCREW	1/4" FROM ENDS & MAX.	
				9 17/32" O.C.	

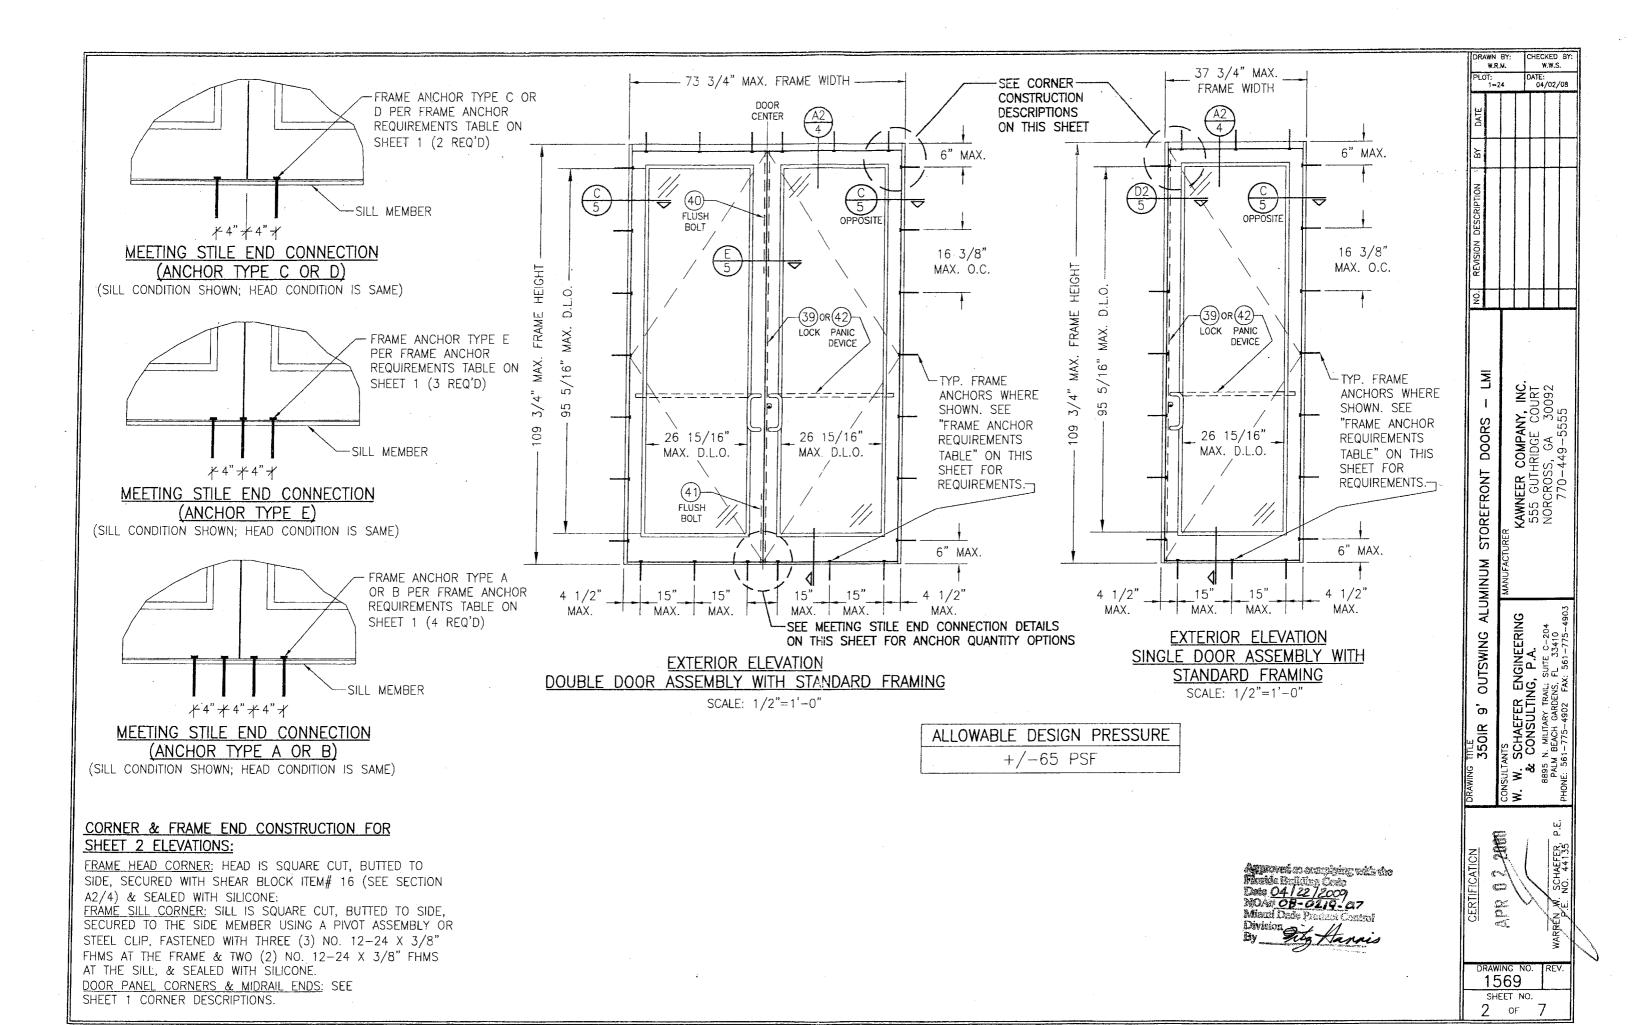

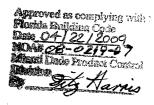

DRAWN BY: W.R.M. CHECKED BY: W.W.S. DATE: 04/02/08

KAWNEER COMPANY, INC. 555 GUTHRIDGE COURT NORCROSS, GA 30092 770-449-5555

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NG TITLE 350IR 9' OUTSWING ALUMINUM STOREFRONT DOORS

A DE A 7 JUNE

DRAWING NO. 1569

SHEET NO. 7

SCHAEFER ENGINEERING CONSULTING, P.A.